




STILLING POND LAYOUT
Scale 1:500

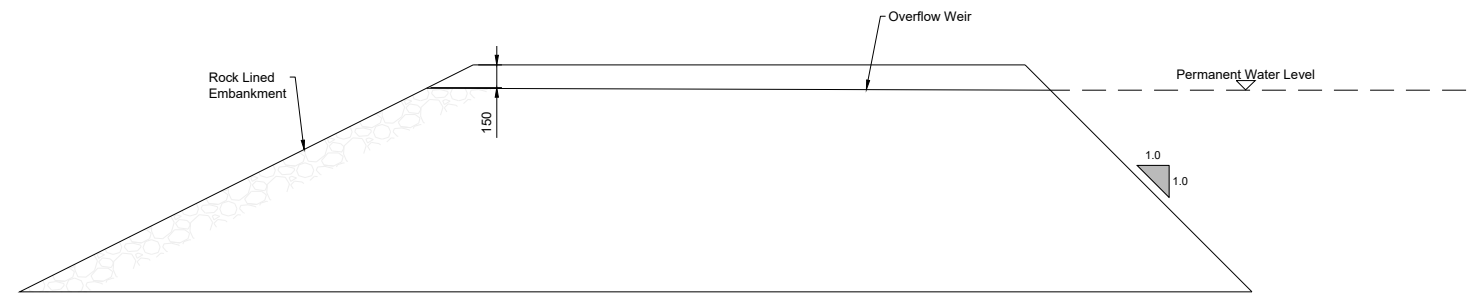

SECTION AT OUTLET
Scale 1:50

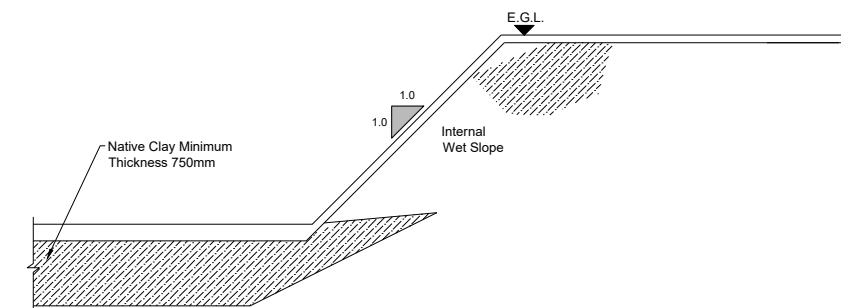

**BUND CONSTRUCTION
(Where Pond is Below Ground Level)**
Scale 1:50

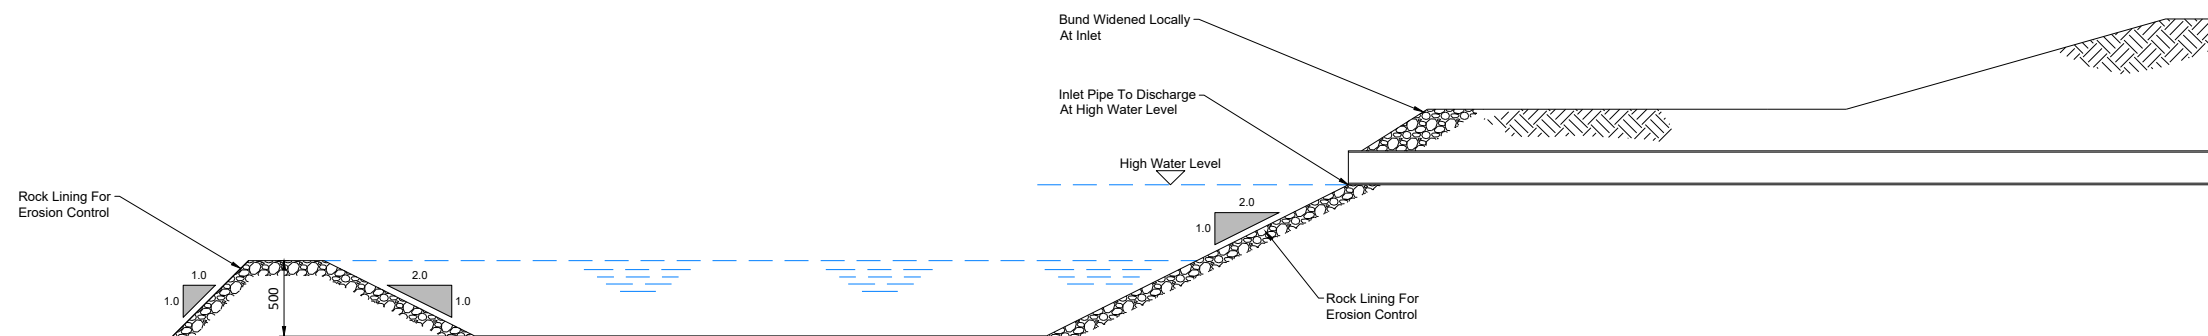

SECTION THROUGH FOREBAY
Scale 1:50

- NOTES**
1. This drawing should only be read in relation to subject of the title. Other information shown on drawing is to be considered indicative only.
 2. All dimensions are in millimetres unless otherwise stated.
 3. The pond base and sides below the permanent water level should be made impermeable by:
Cohesive material using native clay or a synthetic liner 1 mm LLDPE.
 4. Bunds in ponds to be constructed from native clay.
 5. Erosion control to be rock lining. Extent to be agreed on site.
 6. Rock lining to be a 125mm thickness of Class 1B material.
 7. Refer to stilling pond schedules for pond sizes.
 8. Swale inlet at 0.15 m below top of pond.
 9. All ponds to be fenced off.

If Applicable : Ordnance Survey Ireland Licence No. EN 0001219 © Ordnance Survey Ireland and Government of Ireland

Rev.	Description	App By	Date
A	ISSUE FOR APPROVAL	JH	17.09.20
B	ISSUE FOR GENERAL COMMENT FOR ALL DRAWINGS	JH	24.11.20
C	ISSUE FOR PLANNING	JH	11.12.20

PROJECT	CLIENT		
CROAGHAUN WIND FARM	COILLTE		
SETTLEMENT POND DETAIL - SHEET 1 OF 2	Date	17.09.20	Project number
	Drawn by	SOC	P1913
	Checked by	TB	Drawing Number
			P1913-0501-0006
		Scale (@ A3-) As Shown	Rev
			C